


1 PLUMBING PARTIAL FOUNDATION PLAN - AREA V - DEMOLITION
SCALE: 1/8" = 1'-0"

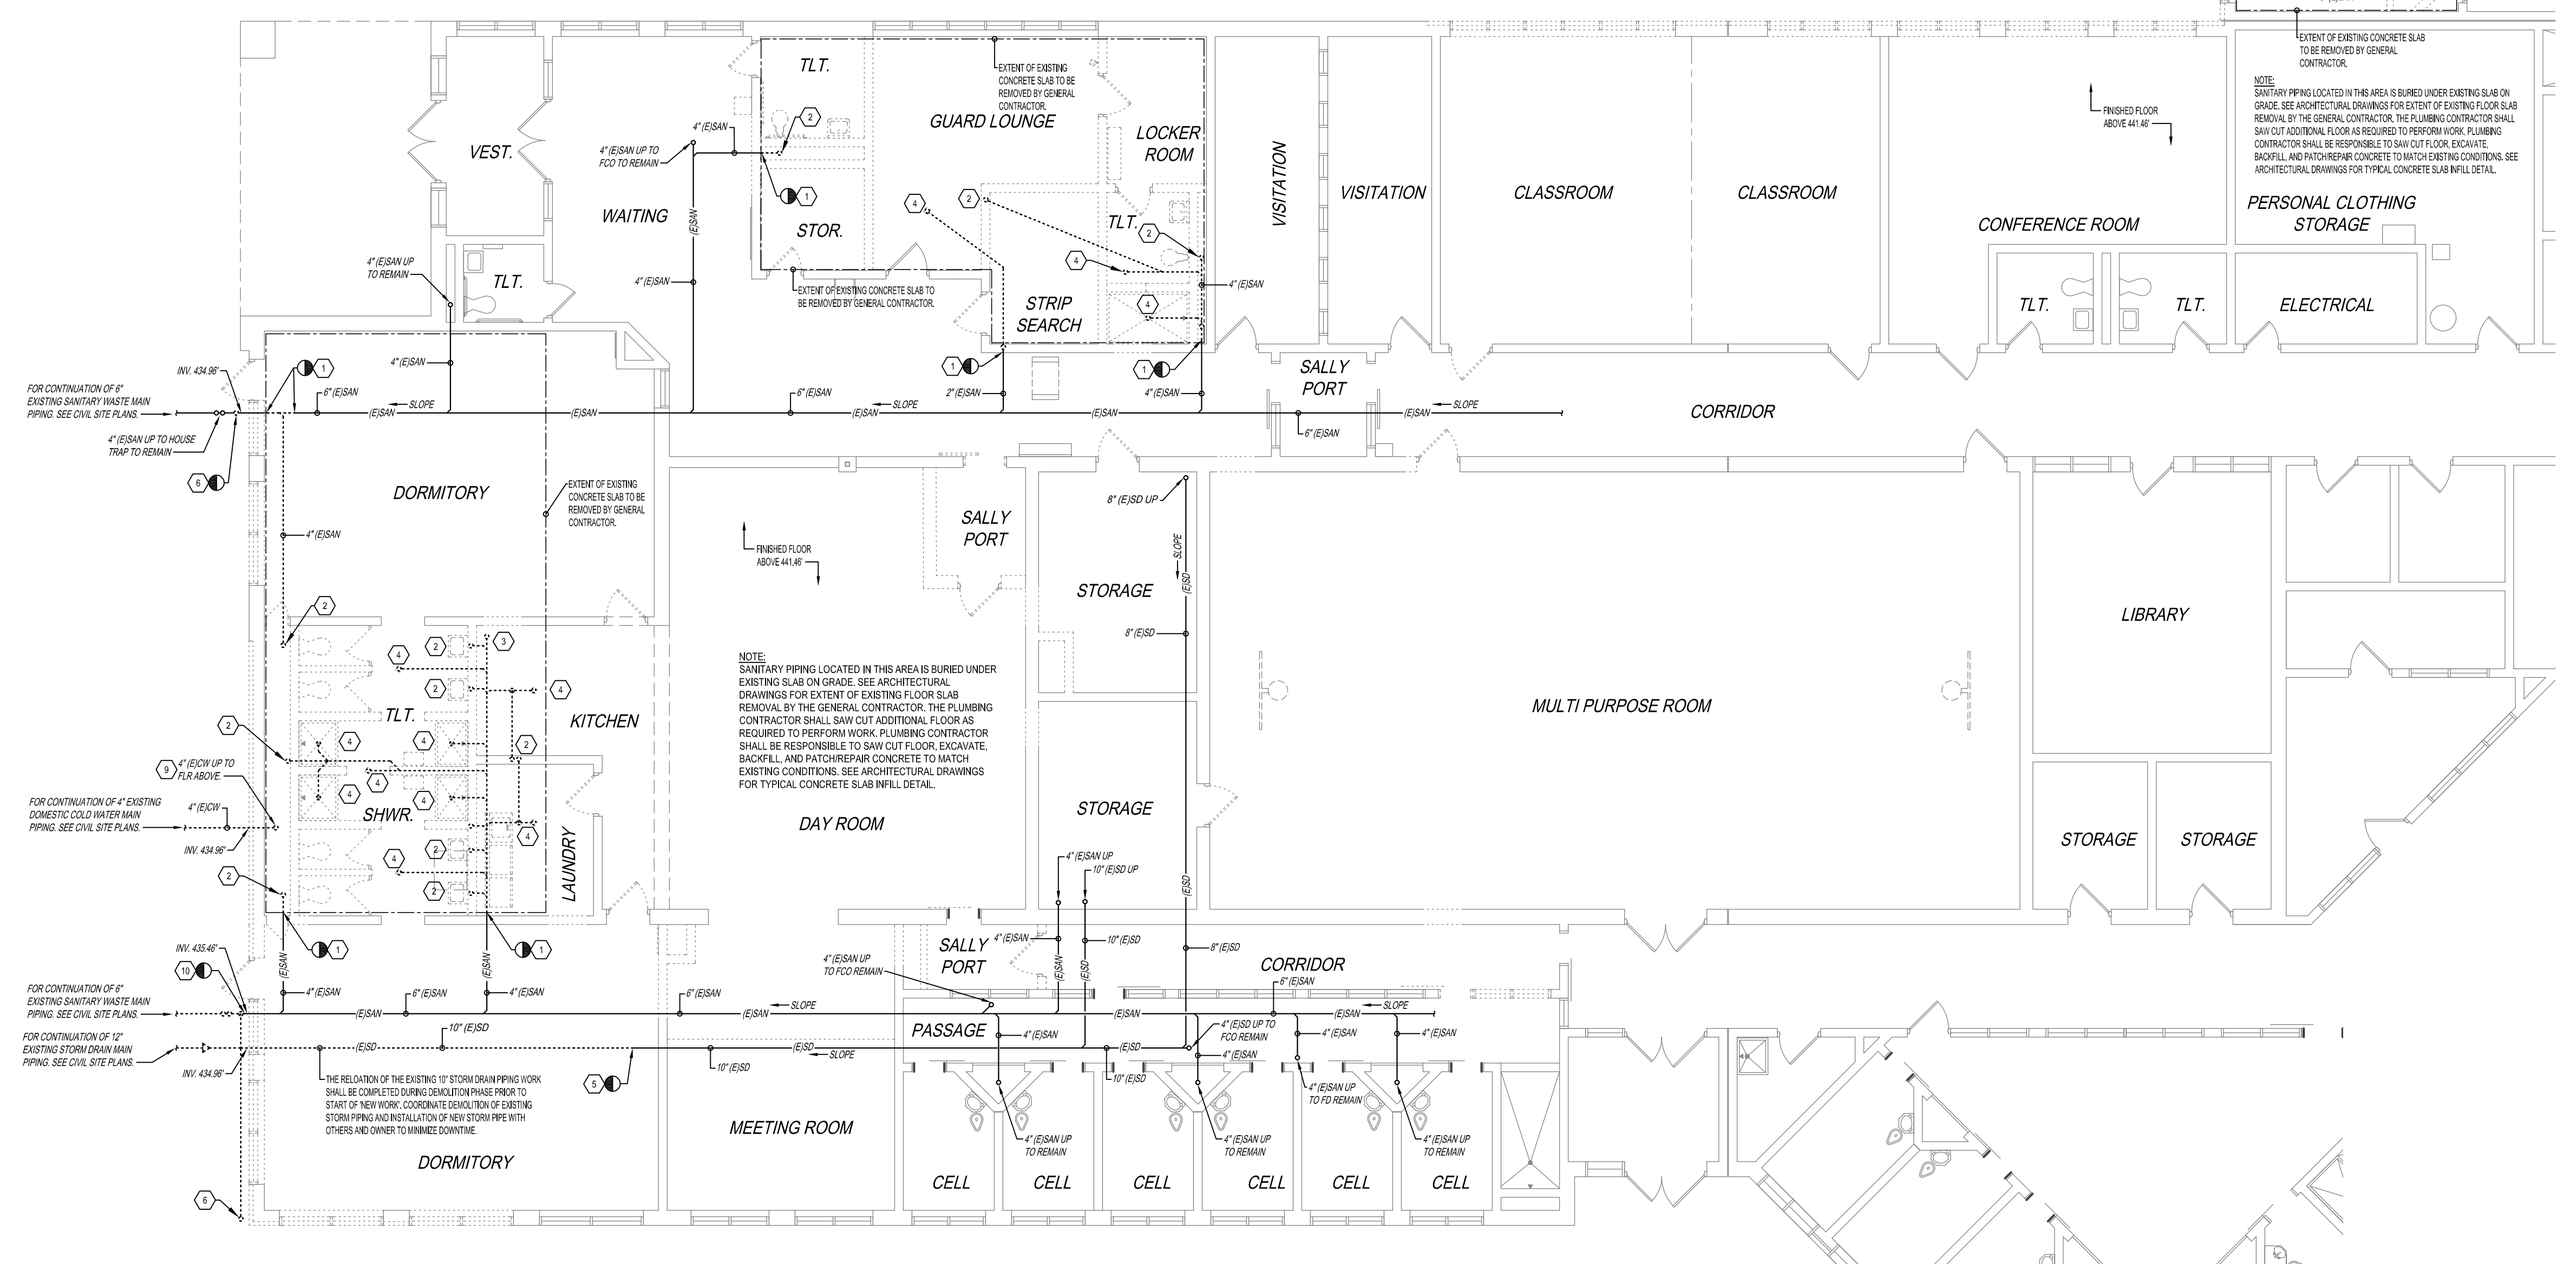

2 PLUMBING PARTIAL FOUNDATION PLAN - AREA N - DEMOLITION
SCALE: 1/8" = 1'-0"


GENERAL SHEET NOTES

- REFER TO P-001 FOR LEGEND AND ABBREVIATIONS
- REFER TO P-501 FOR DETAILS
- VERIFY FINAL EXISTING PIPING LOCATION AND SIZING
- THE CONTRACTOR SHALL PERFORM ALL CUTTING, PATCHING, AND REFINISHING OF DEMOLISHED AREAS AND BUILDING COMPONENTS TO MATCH EXISTING ADJACENT SURFACES
- THE CONTRACTOR SHALL FIELD VERIFY ALL EXISTING DIMENSIONS, CONSTRUCTIONS, AND ASSEMBLIES WITHIN THE EXISTING BUILDING
- THE CONTRACTOR SHALL NOTIFY THE OWNER OF ANY NECESSARY SHUT DOWN OF BUILDING SERVICES PRIOR TO PROCEEDING. THIS CONTRACTOR SHALL PROVIDE TEMPORARY SERVICES AS REQUIRED UNTIL NEW WORK IS COMPLETE
- REMOVE ACT CEILING AND GRID TO PERFORM WORK NOT IN SCOPE OF THIS PROJECT. ALL TILES AND GRID SHALL BE RE-INSTALLED AFTER NEW WORK FINISHED. ALL TILES AND GRID DAMAGED DURING CONSTRUCTION SHALL BE REPLACED BY CONTRACTOR AT THIS CONTRACTORS COST.
- COORDINATE EXISTING UTILITY SHUT-OFFS WITH OWNER AS NOTED IN SPECIFICATION SECTION 22 00 00 - PLUMBING COMMON WORK RESULTS. THE CONTRACTOR SHALL BE RESPONSIBLE FOR PROVIDING TEMPORARY UTILITIES UNTIL PERMANENT SERVICES ARE AVAILABLE
- THE CONTRACTOR SHALL EXCAVATE, BACKFILL, PATCH AND REPAIR TO MATCH EXISTING CONDITIONS AS REQUIRED.

DEMOLITION KEYNOTES (#)

- DISCONNECT AND REMOVE EXISTING SANITARY WASTE PIPING AND ALL ASSOCIATED PIPING TO THIS APPROXIMATE LOCATION. SAW CUT FLOOR, EXCAVATE AND BACKFILL AS REQUIRED TO PERFORM WORK. PATCH AND REPAIR FLOOR TO MATCH EXISTING CONDITIONS.
- DISCONNECT AND REMOVE EXISTING SANITARY PIPING AND ALL ASSOCIATED PIPING IN THEIR ENTIRETY. SAW CUT FLOOR, EXCAVATE, AND BACKFILL AS REQUIRED TO PERFORM WORK. PATCH AND REPAIR FLOOR TO MATCH EXISTING CONDITIONS.
- DISCONNECT AND REMOVE EXISTING CLEANOUT AND ALL ASSOCIATED PIPING IN THEIR ENTIRETY. SAW CUT FLOOR, EXCAVATE AND BACKFILL AS REQUIRED TO PERFORM WORK. PATCH AND REPAIR FLOOR TO MATCH EXISTING CONDITIONS.
- DISCONNECT AND REMOVE EXISTING FLOOR DRAIN AND ALL ASSOCIATED PIPING IN THEIR ENTIRETY. SAW CUT FLOOR, EXCAVATE AND BACKFILL AS REQUIRED TO PERFORM WORK. PATCH AND REPAIR FLOOR TO MATCH EXISTING CONDITIONS.
- DISCONNECT AND REMOVE EXISTING STORM DRAIN PIPING AND ALL ASSOCIATED PIPING TO THIS APPROXIMATE LOCATION. SAW CUT FLOOR, EXCAVATE AND BACKFILL AS REQUIRED TO PERFORM WORK. PATCH AND REPAIR FLOOR TO MATCH EXISTING CONDITIONS.
- DISCONNECT AND REMOVE EXISTING SANITARY BUILDING VENT MUSHROOM CAP. EXCAVATE AND BACKFILL AS REQUIRED TO PERFORM WORK. PROVIDE CAP ON EXISTING PIPE AT BRANCH CONNECTION.
- DISCONNECT AND REMOVE EXISTING DOMESTIC WATER PIPING AND ALL ASSOCIATED APPURTENANCES TO THIS APPROXIMATE LOCATION. EXCAVATE AND BACKFILL AS REQUIRED TO PERFORM WORK. PATCH AND REPAIR WALLS TO MATCH EXISTING CONDITIONS.
- DISCONNECT AND REMOVE EXISTING SANITARY WASTE PIPING AND ALL ASSOCIATED PIPING TO THIS APPROXIMATE LOCATION.
- DISCONNECT AND REMOVE EXISTING DOMESTIC COLD WATER PIPING IN ITS ENTIRETY. EXCAVATE AND BACKFILL AS REQUIRED TO PERFORM WORK. PATCH AND REPAIR WALL TO MATCH EXISTING CONDITIONS. THIS LINE SHALL REMAIN ACTIVE UNTIL THE NEW WATER SERVICE ENTRANCE IS INSTALLED DURING NEW CONSTRUCTION. COORDINATE WORK WITH OTHERS AND OWNER TO MINIMIZE DOWNTIME OF LINE. PROVIDE TEMPORARY WATER SERVICE IF REQUIRED TO MAINTAIN FUNCTIONALITY OF SYSTEM.
- DISCONNECT AND REMOVE EXISTING SANITARY WASTE PIPING AND ALL ASSOCIATED PIPING TO THIS APPROXIMATE LOCATION. SAW CUT FLOOR, EXCAVATE AND BACKFILL AS REQUIRED TO PERFORM WORK. PATCH AND REPAIR FLOOR TO MATCH EXISTING CONDITIONS. THIS LINE SHALL REMAIN ACTIVE UNTIL NEW SANITARY SEWER SERVICE IS INSTALLED DURING NEW CONSTRUCTION. COORDINATE WORK WITH OTHERS AND OWNER TO MINIMIZE DOWNTIME OF LINE.

KEY PLAN

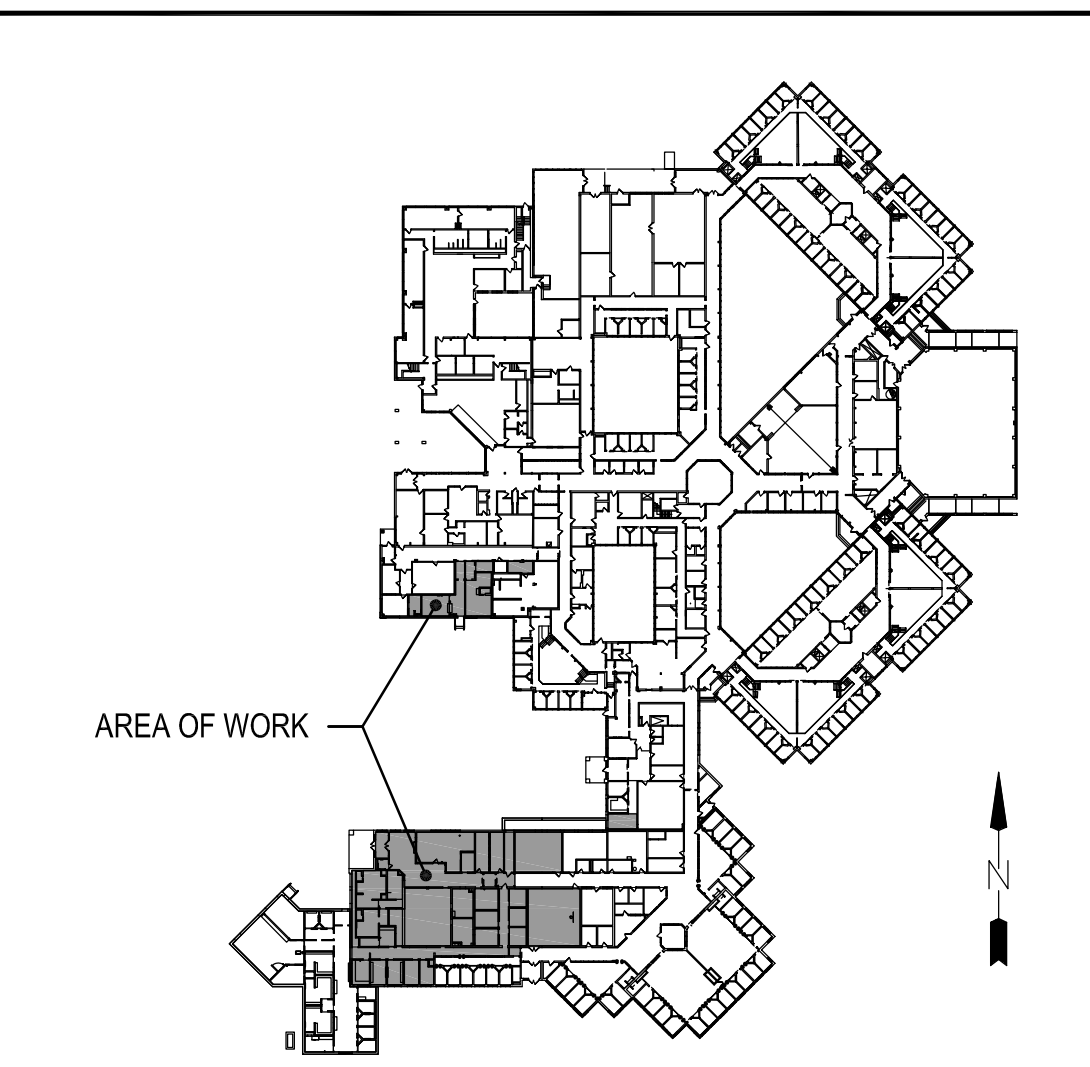

ISSUED FOR BID

REVISIONS	MARK	ISSUED DATE	DESCRIPTION
PROJECT NO:	77332-07	ISSUED DATE:	03/27/23
DRAWN BY:	MFG	CHECKED BY:	MPG
© BUCHART HORN, INC.			
SHEET TITLE: PLUMBING PARTIAL FOUNDATION PLAN - DEMOLITION			
SHEET NO: P-002			