
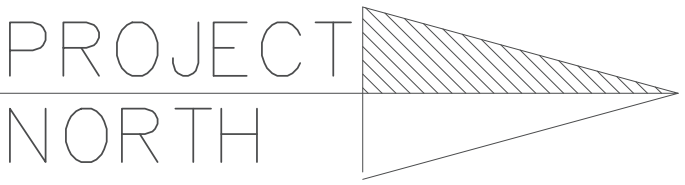


I:\\_2023\225H009 SHT ENGINEERING PLANNING\TASK 20 NEW EQUIPMENT BUILDING\SPEC PACKAGE SHT EQUIPMENT BUILDING\SH1\CONTRACT BID DOCUMENTS\SH1 MUNICIPAL BLDG - 225H009-20.DWG

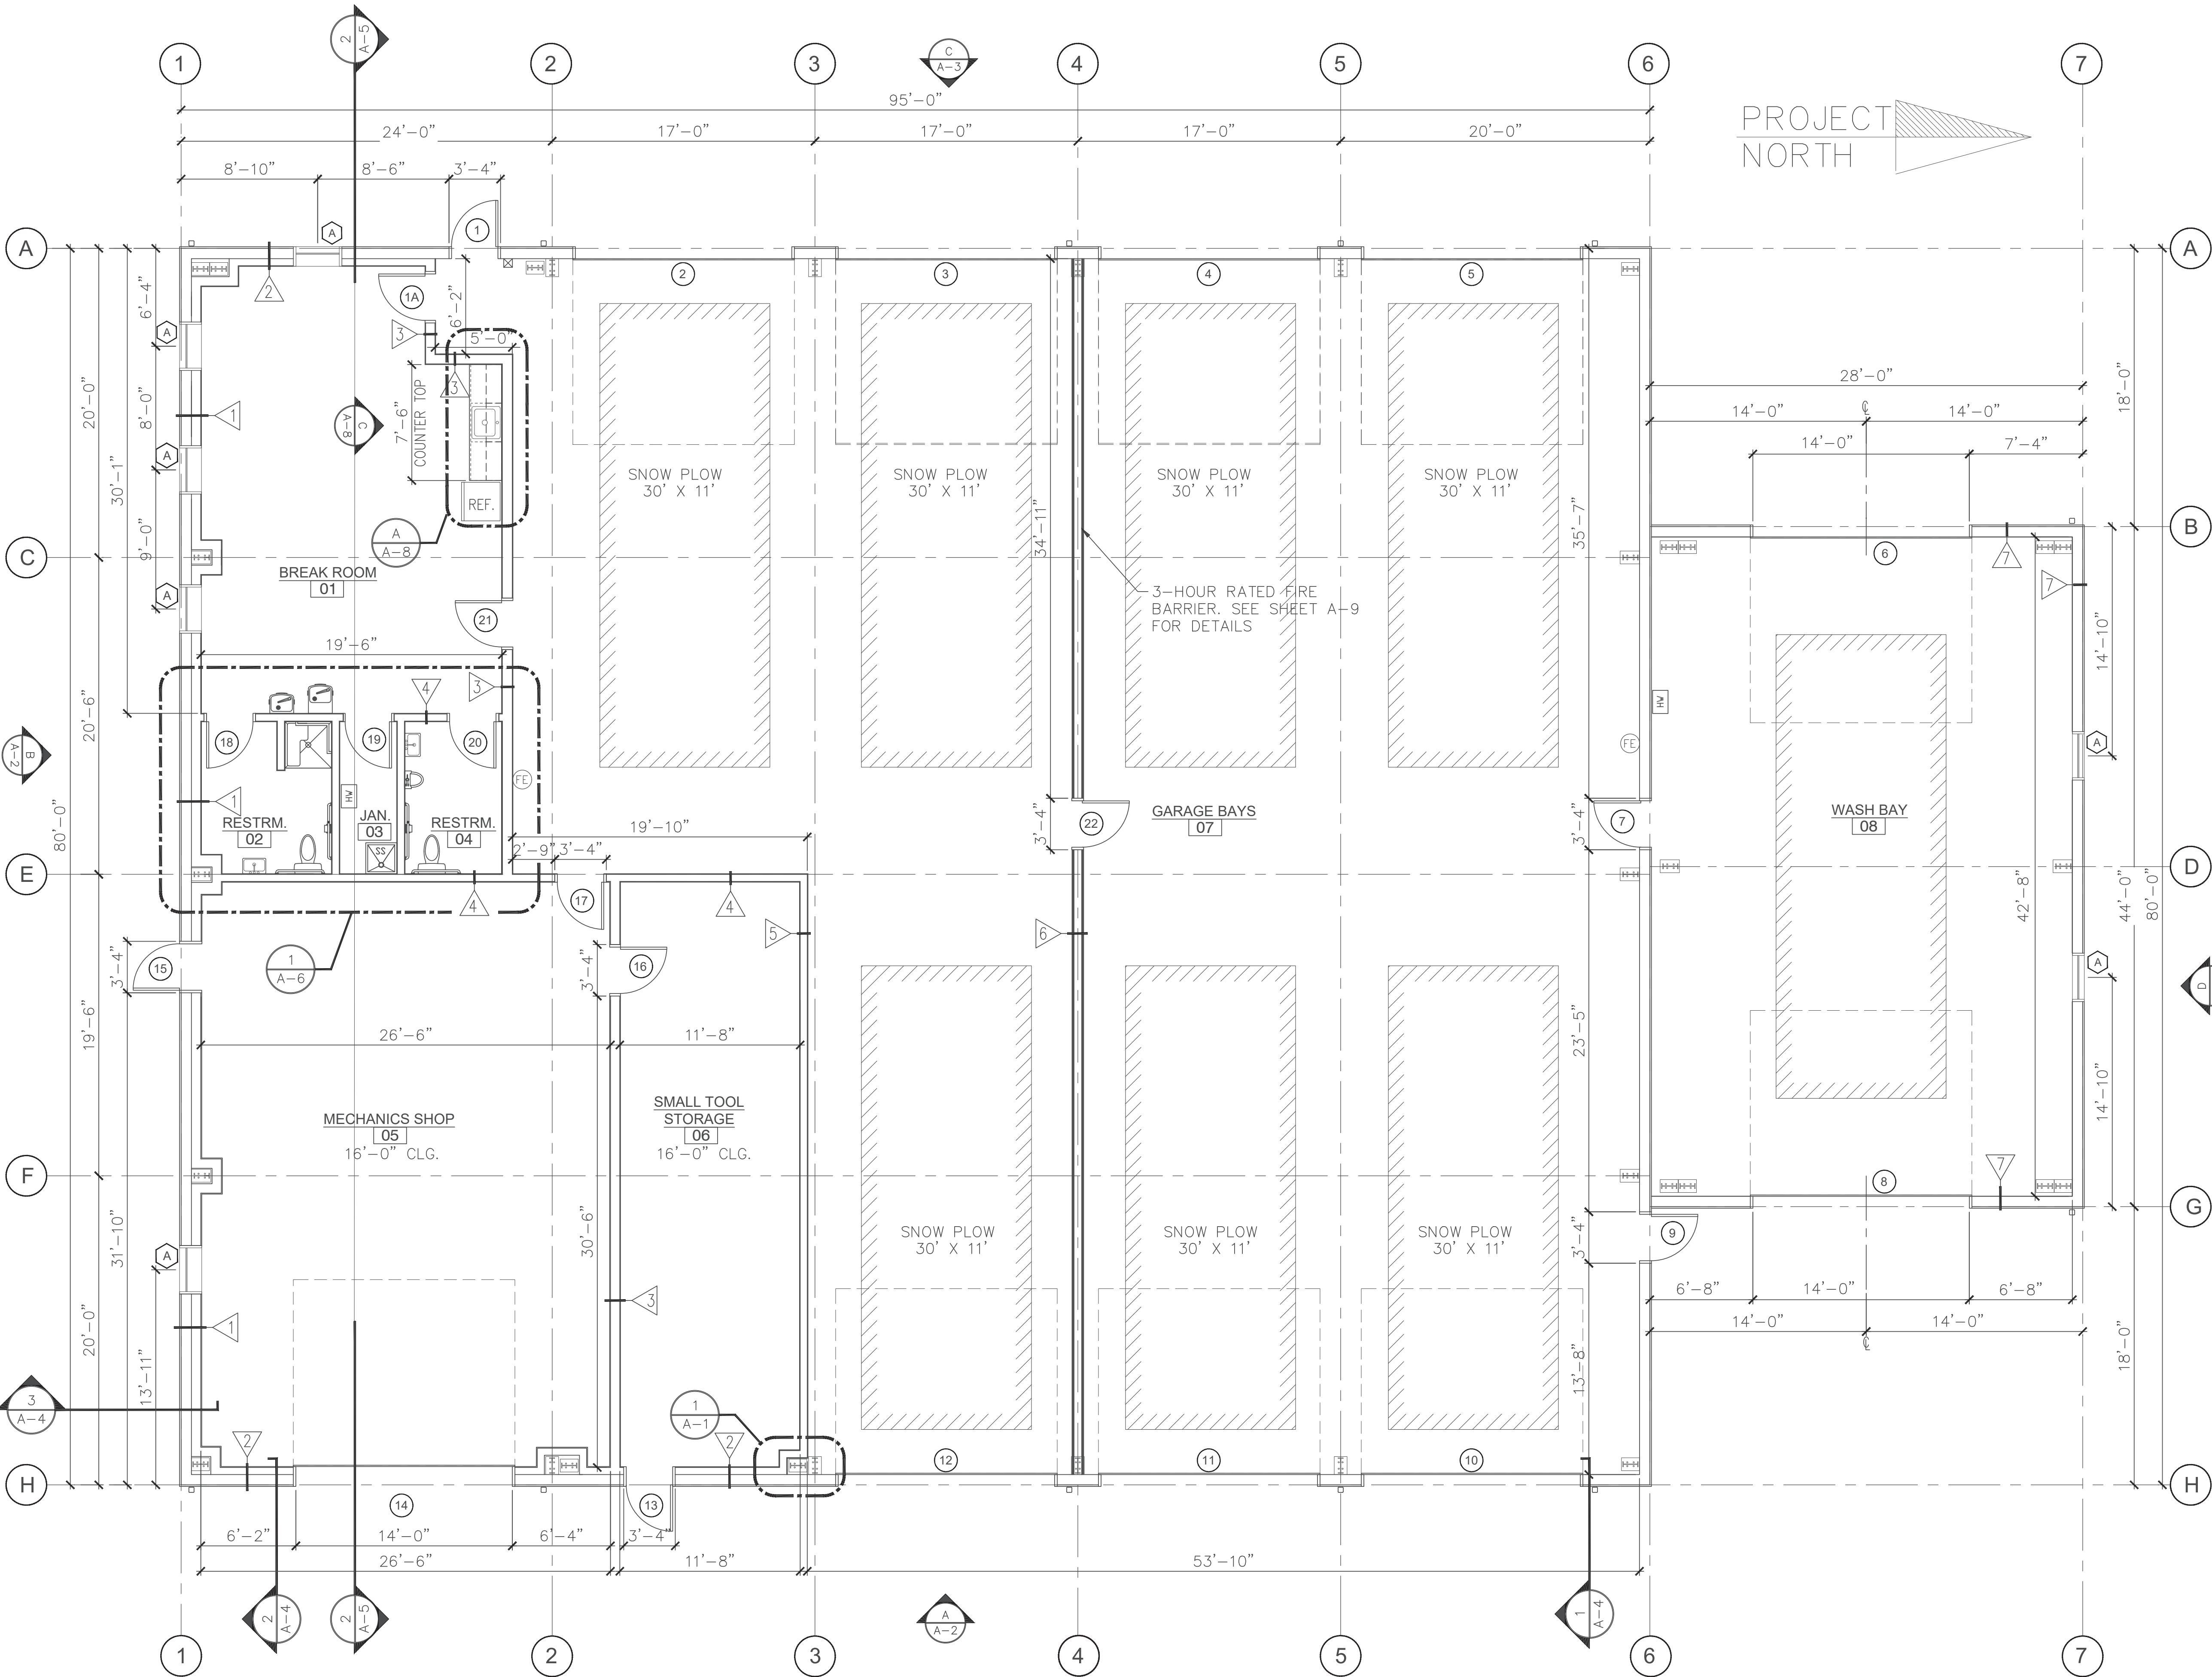


MARK	WALL TYPE DESCRIPTION
1	CORRUGATED METAL PANEL ON ONE SIDE WITH WITH 8" GIRTS, NON-RATED INTERIOR BEARING PARTITIONS & 1/2" PLYWOOD ON THE OTHER SIDE OF 2x8" WOOD STUDS AT 16" O.C.
2	CORRUGATED METAL PANEL ON ONE SIDE WITH WITH 6" GIRTS, NON-RATED INTERIOR NON-BEARING PARTITIONS & 1/2" PLYWOOD ON THE OTHER SIDE OF 2x6" WOOD STUDS AT 16" O.C.
3	NON-RATED INTERIOR BEARING PARTITIONS - 2x8" WOOD STUDS @ 16" O.C. WITH 1 LAYER OF 1/2" GWB. ON BOTH SIDES. (SUBSTITUTE 1/2" PLYWOOD FOR GWB. IN ROOM #5)
4	NON-RATED INTERIOR NON-BEARING PARTITIONS - 2x6" WOOD STUDS @ 16" O.C. WITH 1 LAYER OF 1/2" GWB. ON BOTH SIDES. (SUBSTITUTE 1/2" PLYWOOD FOR GWB. IN ROOM #5)
5	NON-RATED INTERIOR BEARING PARTITIONS - 2x6" WOOD STUDS @ 16" O.C. WITH 1 LAYER OF 1/2" GWB. ON BOTH SIDES.
6	3-HOUR FIRE RATED NON-BEARING WALL - 6" STEEL STUDS, 2 1/2" FIBERGLASS INSULATION, AND 3 LAYERS OF 1/2" TYPE ULIX GWB. ON BOTH SIDES.

SYMBOL LEGEND

- 8 DOOR NUMBER
- A WINDOW TYPE
- 1 WALL TYPE
- A or 1 STRUCTURAL GRID CALLOUTS
- 1 EXTERIOR WALL SECTION
- A-5 BUILDING CROSS SECTION


DIMENSIONS ARE STUD TO STUD

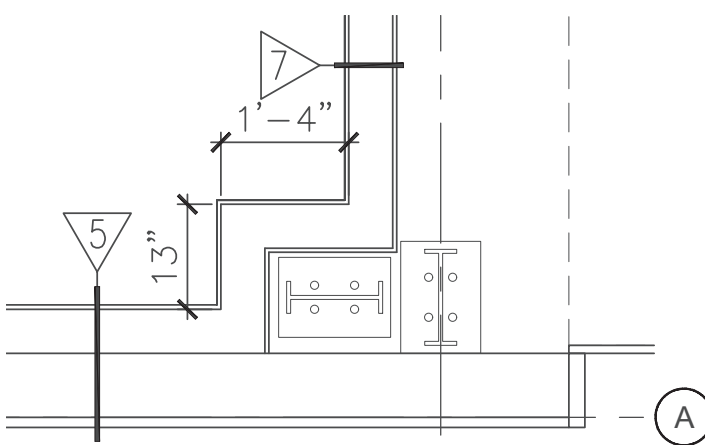

TYP. BOX OUT DETAIL  
SCALE: 1/2" = 1'-0"

Engineer's Stamp:

I certify that to the best of my knowledge and belief this plan is true and correct and the Owner may rely upon the accuracy thereof.

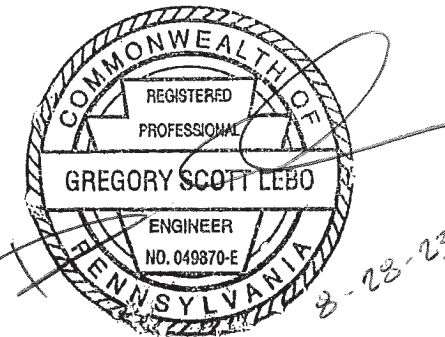

Gregory Scott Lebo, P.E. # 49870-E

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PENNSYLVANIA ONE CALL SYSTEM, INC.  
1-800-242-1776  
PENNSYLVANIA LAW REQUIRES NOT LESS THAN THREE NOR MORE THAN TEN WORKING DAYS NOTICE BEFORE EXCAVATION  
REFER TO PENNSYLVANIA ONE CALL SYSTEM, INC. UTILITY LOCATIONS SHOWN HEREON ARE APPROXIMATE.

FIRST FLOOR PLAN

SCALE: 3/16" = 1'-0"

NOT FOR CONSTRUCTION - ISSUED FOR BID AND PERMIT 08-21-23

DATE	9/14/23
REVISION NOTES	ADDENDUM #3
NO.	1

**BREHM-LEBO ENGINEERING, INC.**  
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FAX: (717) 243-3301

FIRST FLOOR PLAN  
CONSTRUCTION DRAWINGS  
FOR  
TOWNSHIP EQUIPMENT BUILDING  
CUMBERLAND COUNTY, PA  
SOUTHAMPTON TWP.

Drawn By:	DNF
Designed By:	BSC
Checked By:	GSL
File:	2022-SH-009
Date:	8/21/2023
Scale:	3/16"=1'-0"
Drawing No.	

A-1