


PROPOSED BUILDING — SANITARY WASTE & VENT PIPING
SCALE 3/16"=1'-0"

PLUMBING PLAN NOTES:

- 1 2" VENT RISER.
- 2 2" WASTE & 1 1/2" VENT.
- 3 2" WASTE & 2" VENT.
- 4 2" WASTE.
- 5 4" WASTE.
- 6 3" VENT TO 4" VENT THRU. ROOF.
- 7 SANITARY LATERAL RUN BELOW FLOOR SLAB.
- 8 STORM SEWER RUN BELOW FLOOR SLAB.
- 9 FULL SIZE CLEANOUT. TYPICAL.
- 10 CONTINUED ON SITE PLAN BY SITE CONTRACTOR.
- 11 VENT PIPING RUN AS HIGH AS POSSIBLE.
- 12 P.C. SHALL PROVIDE WORK TO 5'-0" OUTSIDE BUILDING.
- 13 P.C. SHALL PROVIDE WORK TO INCLUDE STORM TO OIL INTERCEPTOR AND 5'-0" BEYOND OIL INTERCEPTOR. COORDINATE WITH GENERAL CONTRACTOR AND SITE CONTRACTOR.
- 14 PROVIDE TRAP GUARD IN LIEU OF TRAP PRIMER. VERIFY ACCEPTANCE WITH LOCAL AUTHORITY PRIOR TO CONSTRUCTION.
- 15 DISCHARGE FROM TRENCH DRAINS SHALL BE COLLECTED AND PIPED TO EXTERIOR OIL INTERCEPTOR.
- 16 EXTERIOR OIL INTERCEPTOR TO BE TRAFFIC RATED. SEE SCHEDULE DRAWING P-3.
- 17 FULL SIZE CLEANOUT SAMPLING POINT. TYPICAL 2 PLCS.
- 18 STORM SEWER INSIDE THE BUILDING SHALL BE RUN AT 1/8" PER FOOT SLOPE.
- 19 STORM SEWER OUTSIDE THE BUILDING SHALL BE RUN AT 1/4" PER FOOT SLOPE.
- 20 2" VENT BELOW GRADE.
- 21 2" VENT RISE TO 10' ABOVE FINISHED GRADE AND TERMINATE WITH GOOSENECK AND INSECT SCREEN. PIPING SHALL BE GALVANIZED SCHEDULE 80 STEEL PIPE. INSTALL WITH ANCHOR BELOW GRADE AND SECURE TO BUILDING AS REQUIRED.

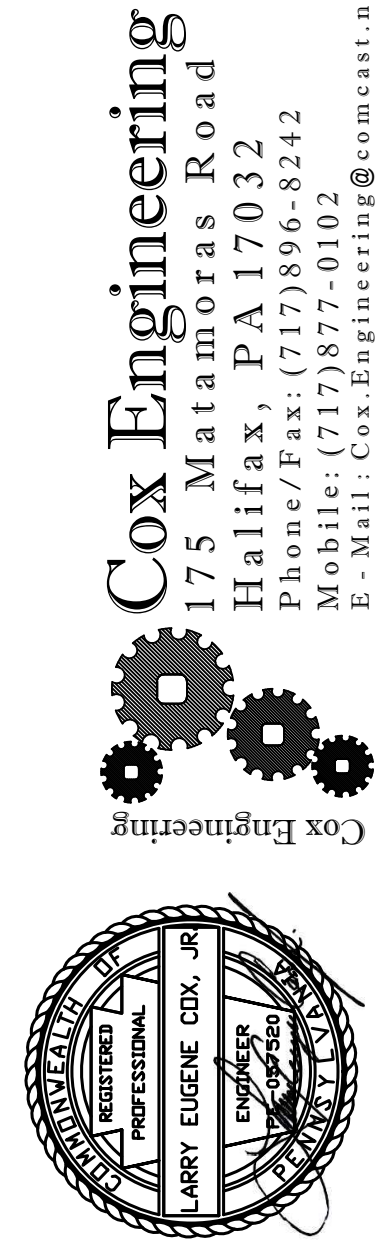

NOT FOR CONSTRUCTION — ISSUED FOR BID AND PERMIT 08-21-23

NO.	REVISION NOTES	DATE

BREHM-LEBO ENGINEERING, INC.
CIVIL ENGINEERS PLANNERS SURVEYORS STRUCTURAL ENGINEERS
17 STATE AVENUE
CARLSLE, PA 17013
PH: (717) 243-4114
FAX: (717) 243-3301

EQUIPMENT BUILDING
CONSTRUCTION DRAWING
FOR
PROPOSED FIRST FLOOR PLAN
CUMBERLAND COUNTY, PA
SOUTHAMPTON TWP.

Drawn By: LEC
Designed By: LEC
Checked By: LEC
File: 2022-SH-009
Date: 08/18/2023
Scale: 3/16"=1'-0"

Drawing No.
P-1

All documents prepared by Brehm-Lebo Engineering, Inc., are instruments of service with respect to this project. They are not intended or represented to be suitable for reuse by owners, contractors or others on extensions of this Project or on any other project. Any reuse without written verification or adaptation by Brehm-Lebo Engineering, Inc., will be at owners sole risk and without liability or legal exposure to Brehm-Lebo Engineering, Inc., and Owner shall indemnify, and hold harmless, Brehm-Lebo Engineering, Inc., from all claims, damages, losses and expenses arising out of or resulting therefrom.

