
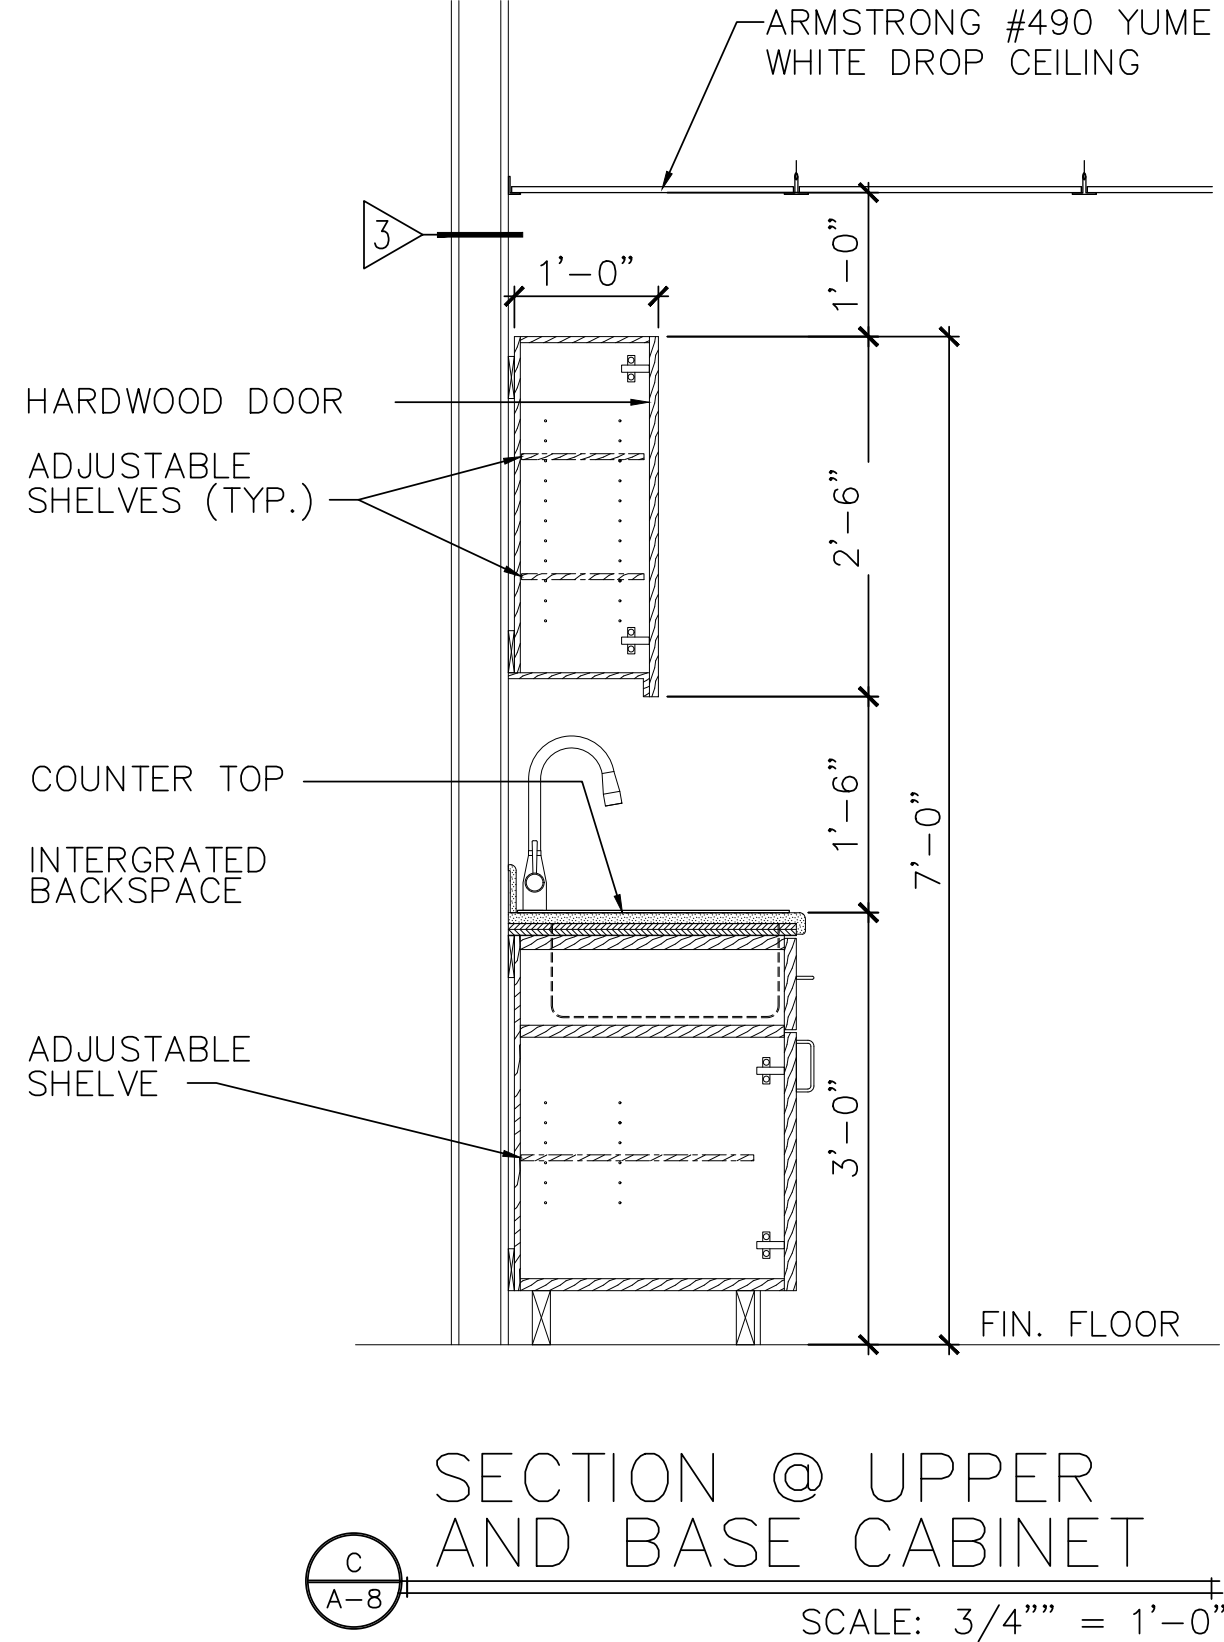
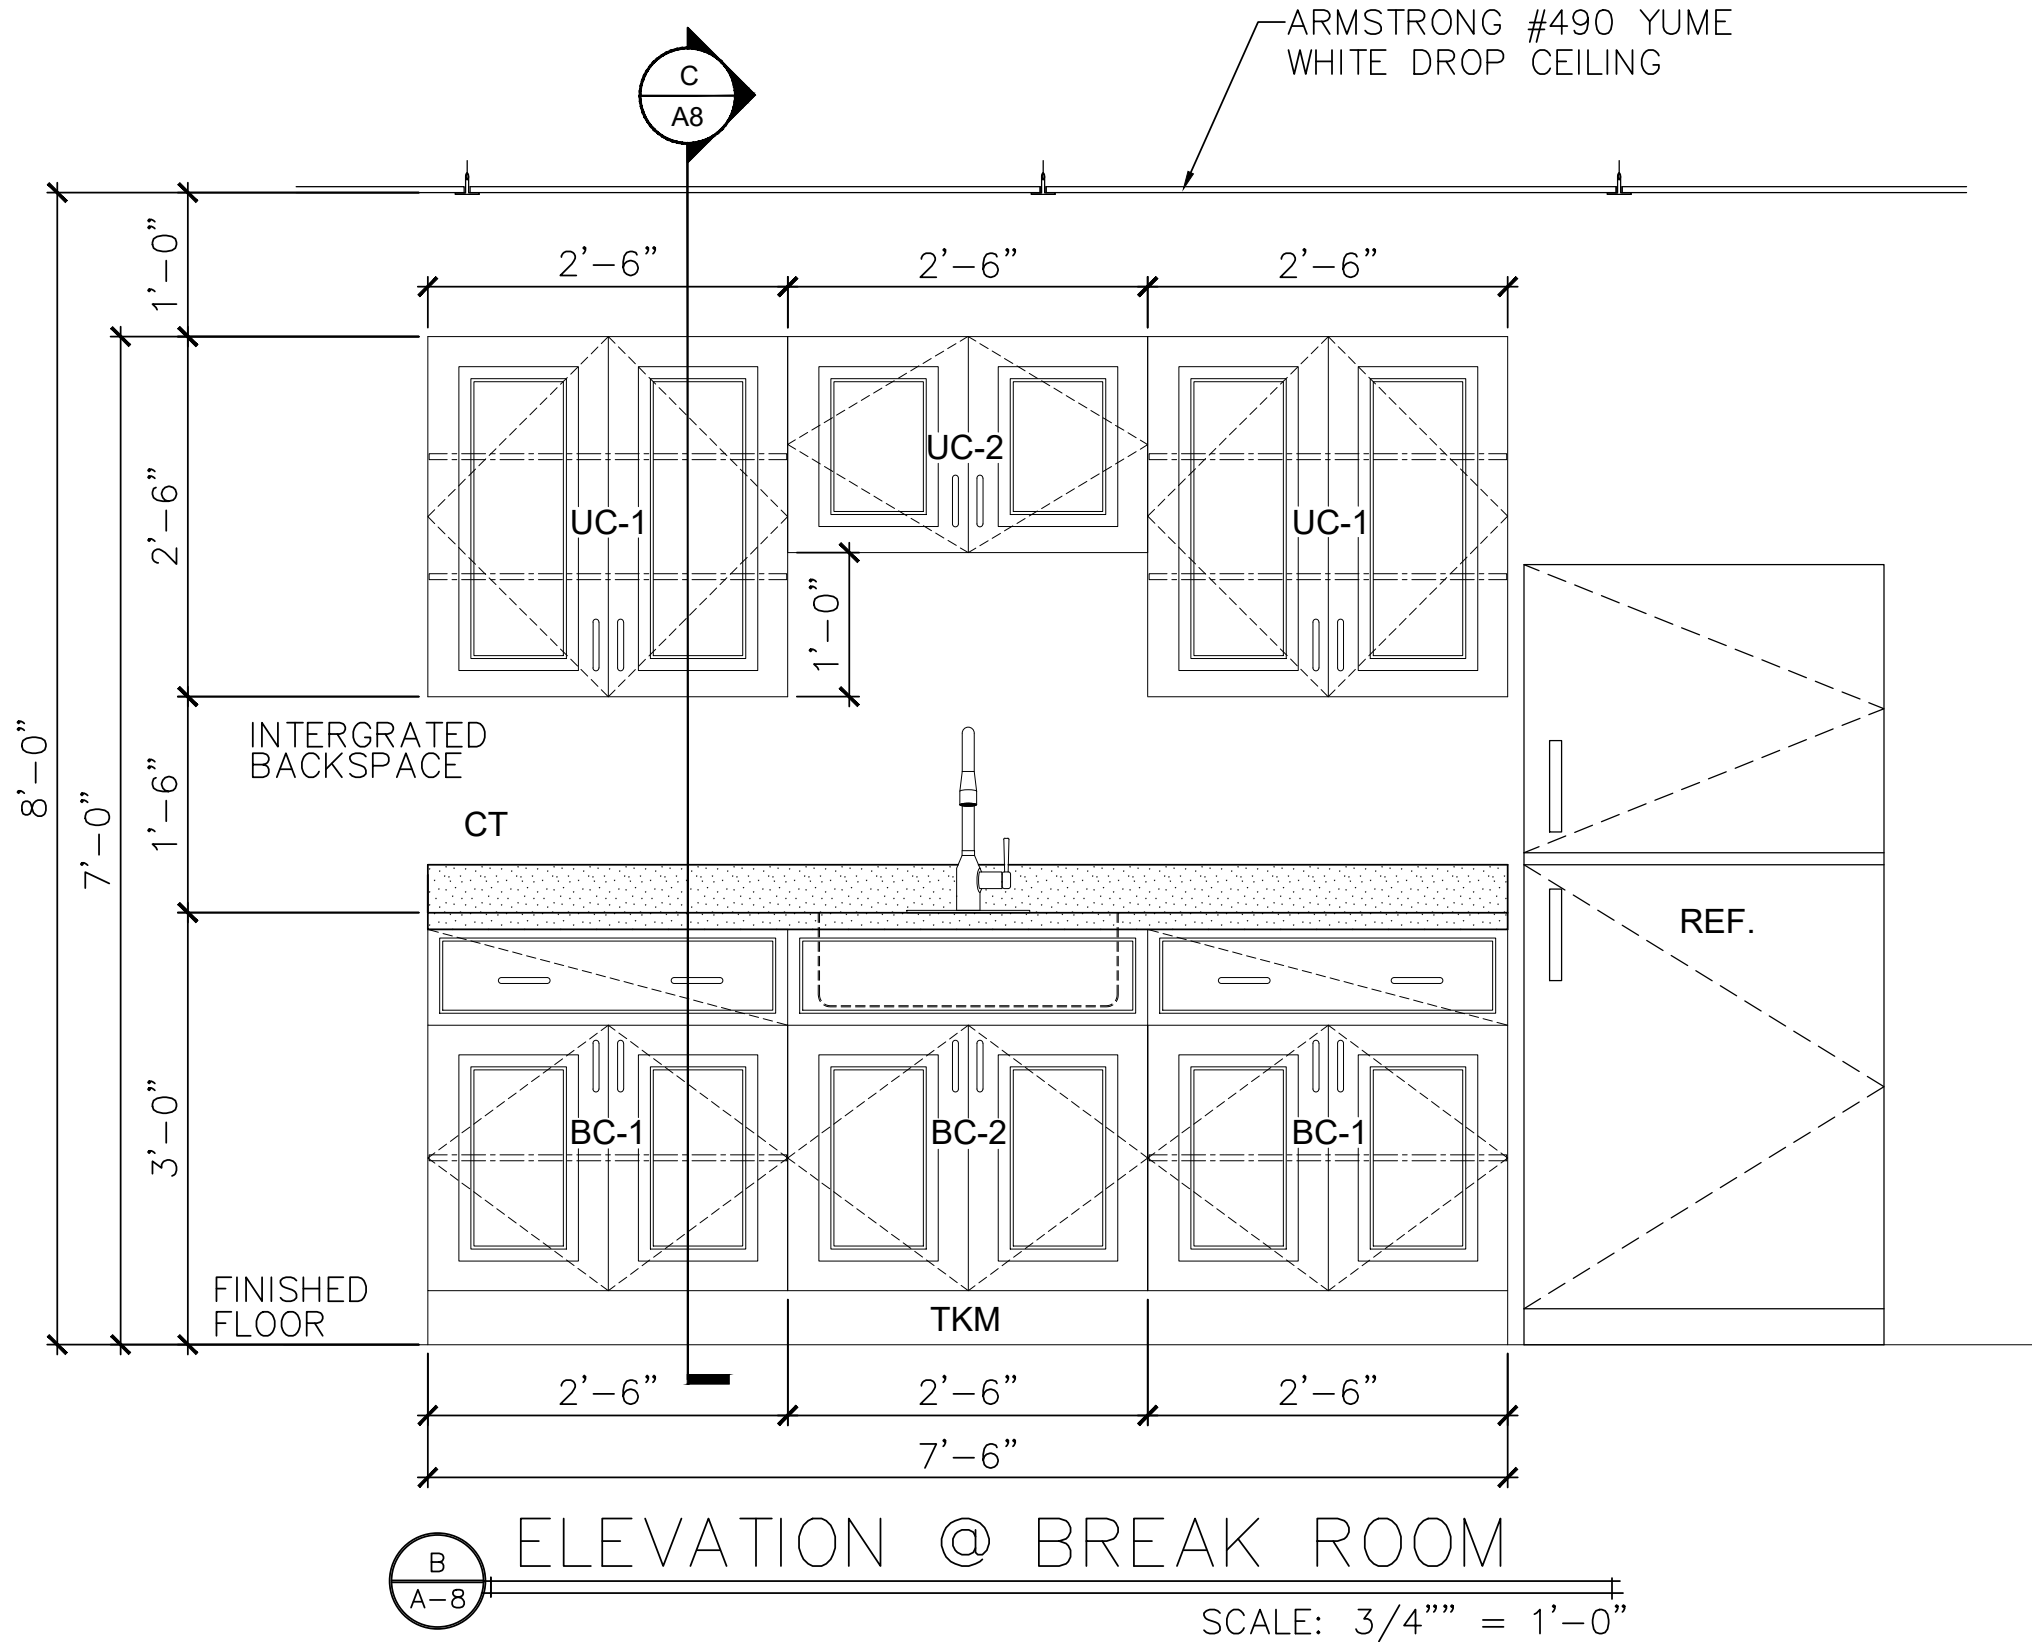


I:\\_2022\225H009 SHT ENGINEERING PLANNING\TASK 20 NEW EQUIPMENT BUILDING\SPEC PACKAGE SHT EQUIPMENT BUILDING\SH1\CONTRACT BID DOCUMENTS\SH1 MUNICIPAL BLDG - 225H009-20.DWG

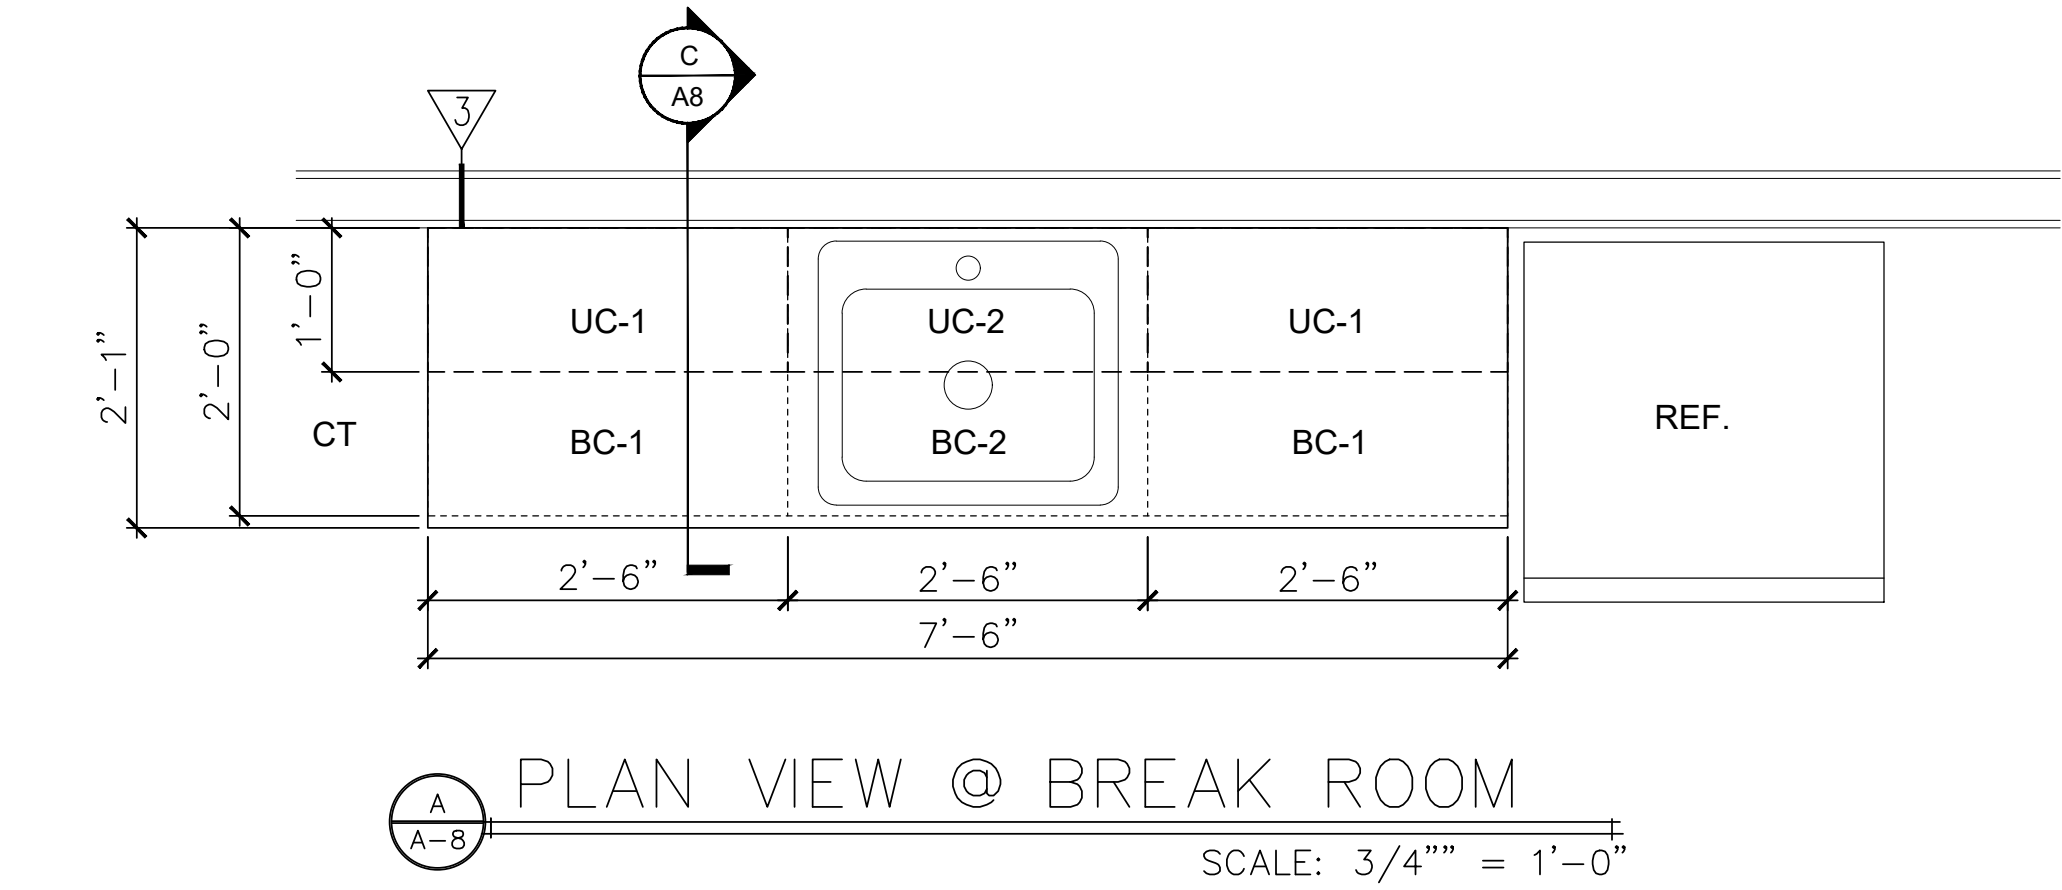

MARK	WALL TYPE DESCRIPTION
1	CORRUGATED METAL PANEL ON ONE SIDE WITH WITH 8" GIRTS, NON-RATED INTERIOR BEARING PARTITIONS & DRYWALL ON THE OTHER SIDE OF 2x8" WOOD STUDS AT 16" O.C.
2	CORRUGATED METAL PANEL ON ONE SIDE WITH WITH 6" GIRTS, NON-RATED INTERIOR NON-BEARING PARTITIONS & DRYWALL ON THE OTHER SIDE OF 2x6" WOOD STUDS AT 16" O.C.
3	NON-RATED INTERIOR BEARING PARTITIONS - 2x8" WOOD STUDS @ 16" O.C. WITH 1 LAYER OF 1/2" GWB. ON BOTH SIDES.
4	NON-RATED INTERIOR NON-BEARING PARTITIONS - 2x6" WOOD STUDS @ 16" O.C. WITH 1 LAYER OF 1/2" GWB. ON BOTH SIDES.
5	NON-RATED INTERIOR BEARING PARTITIONS - 2x6" WOOD STUDS @ 16" O.C. WITH 1 LAYER OF 1/2" GWB. ON BOTH SIDES.
6	3-HOUR FIRE RATED NON-BEARING WALL - 6" STEEL STUDS, 2 1/2" FIBERGLASS INSULATION, AND 3 LAYERS OF 1/2" TYPE ULIX GWB. ON BOTH SIDES.
7	CORRUGATED METAL PANEL ON ONE SIDE WITH WITH 6" GIRTS, AND FRP WALL PANELS.

SYMBOL LEGEND	
	DOOR NUMBER
	WINDOW TYPE
	WALL TYPE
	STRUCTURAL GRID CALLOUTS
	EXTERIOR WALL SECTION
	BUILDING CROSS SECTION
DIMENSIONS ARE STUD TO STUD	

CABINET SCHEDULE												
ITEM DESIGNATION	QUANTITY	CABINET TYPE		DOOR STYLE & FINISHES	#DRWS	SHELVES	DIMENSIONS			MANUFACTURER	CATALOG NUMBER	NOTES
		UPPER CABINET	LOWER CABINET				LENGTH	DEPTH	HEIGHT			
BC-1	2		BASE	HAMPTON (RFT)	1	2	30"	24"	34-1/2"	HAMPTON BAY	KB30-SJM	
BC-2	1		SINK BASE	HAMPTON (RFT)	—	—	30"	24"	34-1/2"	HAMPTON BAY	KSB30-SJM	
UC-1	2	HIGH WALL		HAMPTON (RFT)	—	3	30"	12"	18"	HAMPTON BAY	KW3030-SJM	
UC-2	1	HIGH WALL BRIDGE		HAMPTON (RFT)	—	—	30"	12"	18"	HAMPTON BAY	KW3018-SJM	
TKM	1	TOE KICK MOLDING			—	—	—	—	4"	HAMPTON BAY	KATXX-JM	
CT	1	COUNTERTOP			—	—	78"	24"	—	HAMPTON BAY	011312010895008	WILSONART STRAIGHT LAMINATE COUNTERTOP IN TEXTURED PRALINE ANTICO WITH WATERFALL EDGE & INTERGRATED BACKSPLASH


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REFER TO PENNSYLVANIA ONE CALL SYSTEM, INC. UTILITY LOCATIONS SHOWN HEREON ARE APPROXIMATE.

#### Engineer's Stamp:

I certify that to the best of my knowledge and belief this plan is true and correct and the Owner may rely upon the accuracy thereof.



Gregory Scott LeBO, P.E. # 49870-E

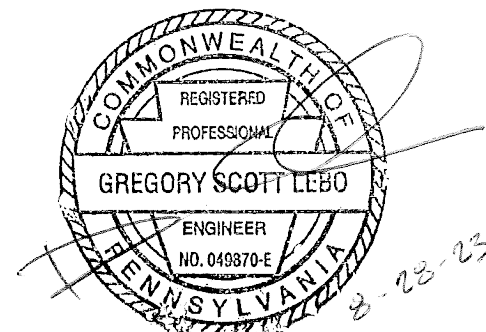KITCHEN CABINETS & SCHEDULES

CONSTRUCTION DRAWINGS

FOR TOWNSHIP EQUIPMENT BUILDING

SOUTHAMPTON TWP. CUMBERLAND COUNTY, PA

**BREHM-LEBO ENGINEERING, INC.**

CIVIL ENGINEERS • PLANNERS • SURVEYORS • STRUCTURAL ENGINEERS

17 STATE AVENUE  
CARLISLE, PA 17013  
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FAX: (717) 245-3301



NOT FOR CONSTRUCTION - ISSUED FOR BID AND PERMIT 08-21-23

DATE

REVISION NOTES

NO.

Drawn By: DNF

Designed By: BSC

Checked By: GSL

File: 2022-SH-009

Date: 8/21/2023

Scale: AS NOTED

Drawing No.

A-8